Appendix I

規劃署

粉嶺、上水及元朝東規劃處 新界荃灣青山公路 388 號 中染大廈 22 楼 2202 室



Planning Department

Fanling, Sheung Shui & Yuen Long East District Planning Office Unit 2202, 22/F, CDW Building, 388 Castle Peak Road, Tsuen Wan, N.T.

來承檔號

Your Reference:

本署檔號

Our Reference:

TPB/A/YL-SK/292

電話號碼

Tel. No.:

3168 4072

傳真機號碼

Fax No.:

3168 4074/3168 4075

By Post & Fax (2323 3662)

R-riches Property Consultants Limited Block D, The Richfield, No. 236 Kat Hing Wai, Kam Tin, N.T., Hong Kong (Attn: Matthew NG/ Grace WONG)

18 June 2024

Dear Sir/ Madam,

Submission for Compliance with Approval Condition (d) the Submission of a Drainage Proposal

Proposed Temporary Shop and Services for a Period of 5 Years and Filling of Land in "Village Type Development" Zone, Lot 591 RP (Part) in D.D. 112, Shek Kong, Yuen Long

(Application No. A/YL-SK/292)

I refer to your submission dated 14.5.2024 for compliance with the captioned approval condition. The relevant department has been consulted on your submission. Your submission is considered:

\checkmark	Acceptable.	The captioned	condition	has been	complied	with.
	1. Table 1.					

- Acceptable. Since the captioned condition requires both the submission and implementation of the proposal, it has not been fully complied with. Please proceed to implement the accepted proposal for full compliance with the approval condition.
- □ Not acceptable. The captioned condition <u>has not been complied with</u>.

Should you have any queries, please contact Mr. Kenneth Y L Chan (Tel.: 2300 1259) of the Drainage Services Department directly.

Yours faithfully,

(KWNG)

District Planning Officer/ Fanling Sheung Shui & Yuen Long East

Planning Department

透過規劃工作,使香港成為一個宜居、具競爭力和可持續發展的**亞洲國際都會**We plan to make Hong Kong a Liveable • Competitive • Sustainable ASIA'S WORLD CITY

- 2 -

c.c. CE/MN, DSD

(Attn.: Mr. Kenneth Y L Chan)

Internal CTP/TPB

KWN/RS/MS/th

Appendix

Comments of the Director of Drainage Services:

(i) The applicant should implement the drainage facilities on site in accordance with the agreed drainage proposal.

(ii) The applicant is required to rectify the drainage system if they are found to be inadequate or ineffective during operation. The applicant shall also be liable for and shall indemnify claims and demands arising out of damage or nuisance caused by a failure of the drainage system.

- (iii) The applicant is required to maintain all the drainage facilities on site in good condition and ensure that the proposed development would neither obstruct overland flow nor adversely affected any existing natural streams, village drains, ditches and the adjacent areas.
- (iv) The existing drainage facilities, to which the stormwater of the development from the subject site would discharge, are not maintained by this office. The applicant should identify the owner of the existing drainage facilities to which the proposed connection will be made. In the case that it is a local village drains, District Office/Yuen Long should be consulted. The applicant shall resolve any conflict/disagreement with relevant lot owner(s) and seek Lands Department's permission for laying new drains/channels and/or modifying/upgrading existing ones in other private lots or on Government land outside the application site.



Our Ref.: DD112 Lot 591 RP Your Ref.: TPB/A/YL-SK/292

顧問有限公司 **盈卓物業**

The Secretary,
Town Planning Board,
15/F, North Point Government Offices,
333 Java Road,
North Point, Hong Kong

By Email

14 May 2024

Dear Sir,

Compliance with Approval Condition (d)

Proposed Temporary Shop and Services (Solar Power System Shop)
for a Period of 5 Years and Filling of Land in "Village Type Development" Zone,
Lot 591 RP (Part) in D.D. 112, Shek Kong, Yuen Long, New Territories

(S.16 Planning Application No. A/YL-SK/292)

We are writing to submit a response-to-comments table and a revised drainage proposal for compliance with approval condition (d) of the subject application, i.e. *the submission of a drainage proposal* (**Appendices I** and **II**).

	Should you require more information regarding	g the application, please contact our M	lr. Louis
TSE at	ort	the undersigned at your convenience.	Thank
you fo	r your kind attention.		

Yours faithfully,

For and on behalf of

R-riches Property Consultants Limited

Matthew NG

Planning and Development Manager

(Attn.:

cc DPO/FSYLE, PlanD




<u>Appendix I – Response to Comments of the Chief Engineer/Mainland North, Drainage Services</u> <u>Department (CE/MN, DSD)</u>


Comments of the CE/MN, DSD					
(Con	(Contact Person Ms. Vickt SY; Tel: 2300 1347)				
(i)	The existing stormwater drainage system proposed for discharge of the runoff from the application site(s) is not maintained by DSD. The applicants) shall resolve any conflict/disagreement arisen for discharging the runoff from the application site(s) to the proposed discharge points). Moreover, the applicants) should ensure that this drainage system and the existing downstream drains/channels/streams have adequate capacity to convey the additional runoff from the application site(s). Regular maintenance should be carried out by the applicant(s) to avoid blockage of the system. In the case that it is a local village drains, District Office/ Yuen Long should be consulted;	Noted.			
(ii)	The proposal should indicate how the runoff (the flow direction) within the site would be discharged to the proposed uchannel;	Flow direction in Fig.1 is provided for reference (Appendix II).			
(iii)	Cross sections showing the existing and proposed ground levels of the captioned site with respect to the adjacent areas should be given;	Cross-sections showing the existing and proposed ground level are provided for your consideration (Appendix II).			
(iv)	Where walls or hoarding are erected are laid along the site boundary, adequate opening should be provided to intercept the existing overland flow passing through the site;	No walls or hoarding are proposed.			
(v)	The development should neither obstruct overland flow nor adversely affect existing natural streams, village drains, ditches and the adjacent areas, etc.; and	Noted.			




(vi)	The applicant(s) shall resolve any Noted.
	conflict/disagreement with relevant lot
	owners) and seek Lands Department's
	permission for laying new drains/channels
	and/or modifying/upgrading existing ones
	in other private lots or on Government land
	(where required) outside the
	application site(s).




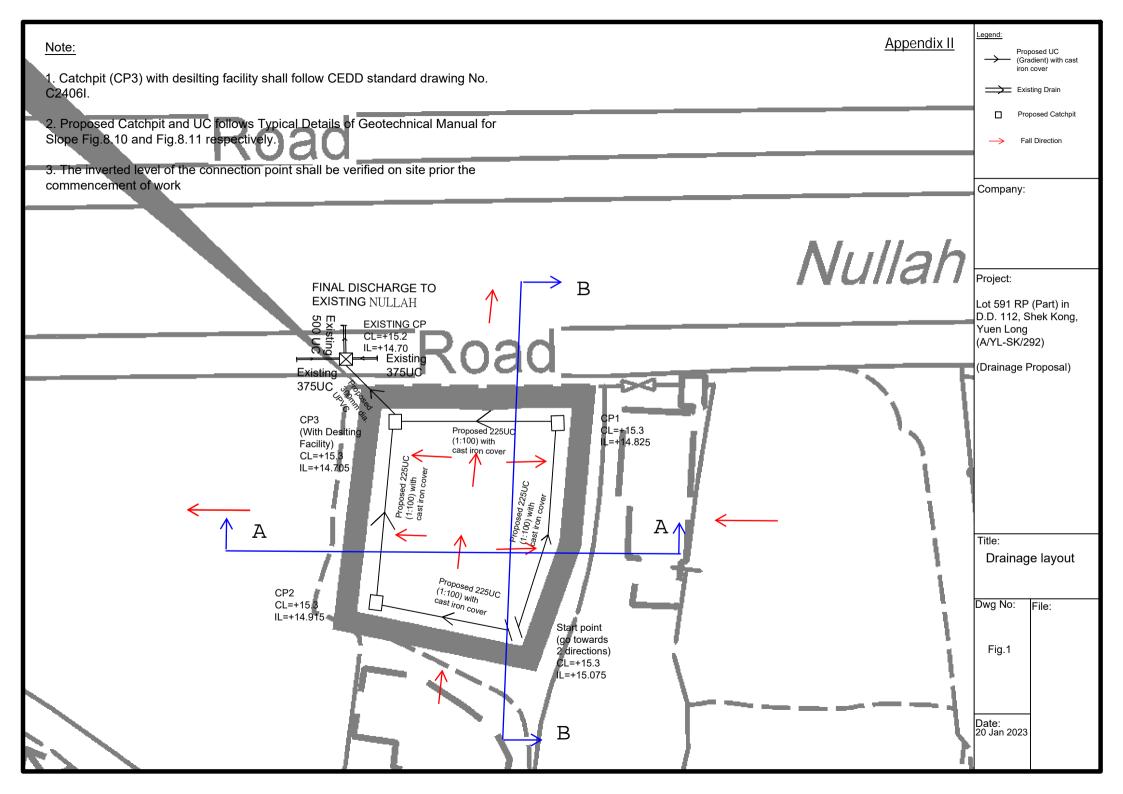

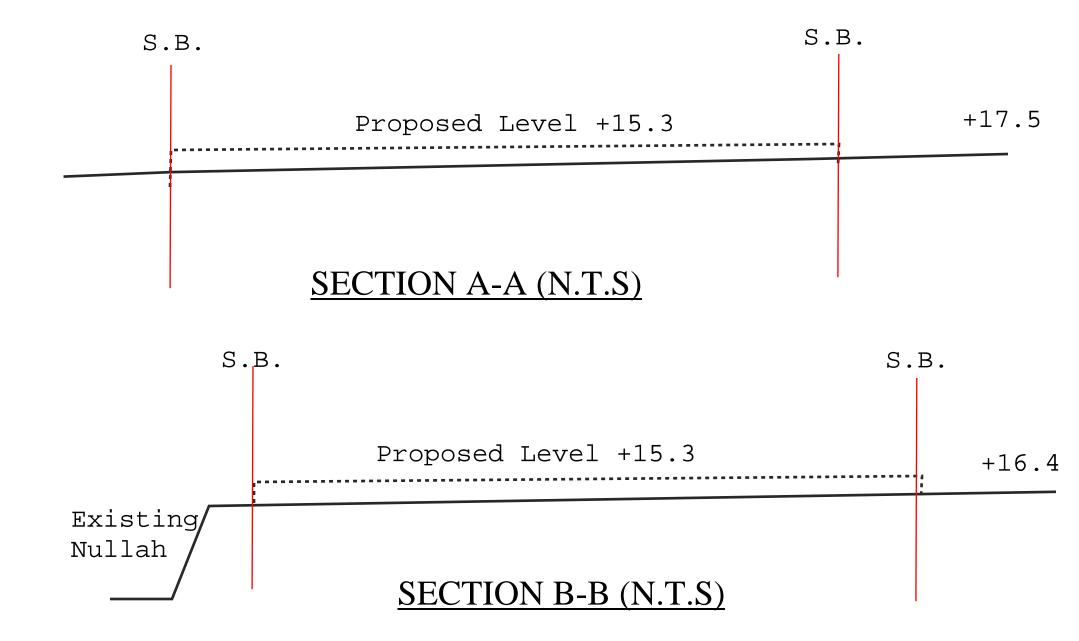

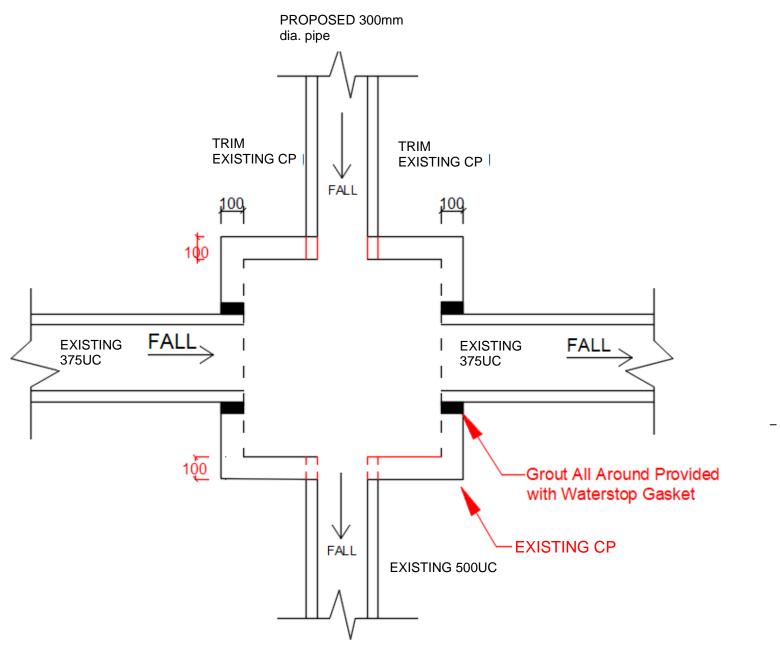

EXISTING CP - CONNECTION DETAIL

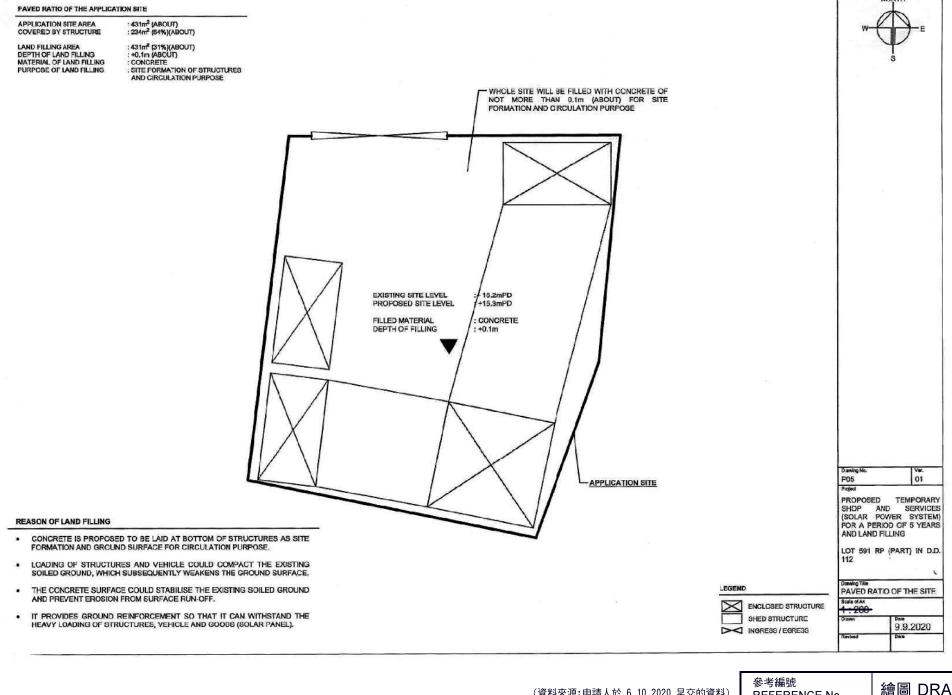

(資料來源:申請人於 6.10.2020 呈交的資料)

(Source : Applicant's Submission of 6.10.2020)

REFERENCE No. A/YL-SK/292

繪圖 DRAWING A-3

Assume return period T = 50years

According to Table 3a of SDM 2018,

$$a = 451.3$$
, $b = 2.46$, $c = 0.337$

$$i = \frac{a}{(td+b)^{C}}$$

Duration in minutes is taken as 6 mins

According to Table 28 of SDM, 2018, rainfall increase = 10.4%

$$i = \frac{451.3}{(6+2.46)^{0.337}}(1+10.4\%) = 220 \times (1+10.4\%) = 243 \text{ min/hr}$$

For conservative design, i = 250 min/hr is taken.

Catchment Area =810.6m² (including proposed development area and existing development).

Surface runoff coeficient C = 0.95

Qp= 0.278CiA

$$= 0.278 (0.95) (250) (810 \times 10^{-6})$$

= 0.0535m3/s = 3208 litre /min

Check Proposed 300mm ∅ concrete pipe by Colebook - white Equation.

$$V = \sqrt{(8gDs)} \log \left(\frac{ks}{3.7D} + \frac{2.51v}{D/2gDs} \right)$$

 $g = 9.81 \text{m/s}^2$

D = 0.3m

Ks = 0.00015m (Table 5, from DSD Sewage Manual, concrete pipe)

$$v = 1.14 \times 10^{-6} \text{ m}^2/\text{s}$$

S = 0.015


Cross-Section Area =
$$\frac{\text{TV }(0.3)^2}{4}$$
 = 0.0707 m²

Therefore, design velocity of pipe capacity = 2.24m/s


> velocity from catchment area

$$=\frac{0.0535}{0.0707}$$
 = 0.757m/s OK!


As a result, proposed 225UC and proposed 300mm dia underground pipe can cater the surface runoff due to proposed development

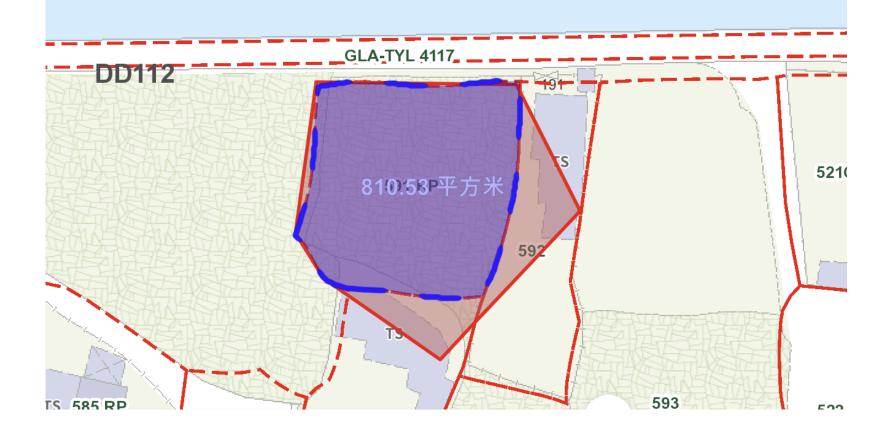

Slopes Guidelines on Hydraulic Design of U-shaped and Half-round Channels on GEO Technical Guidance Note No. 43 (TGN 43)

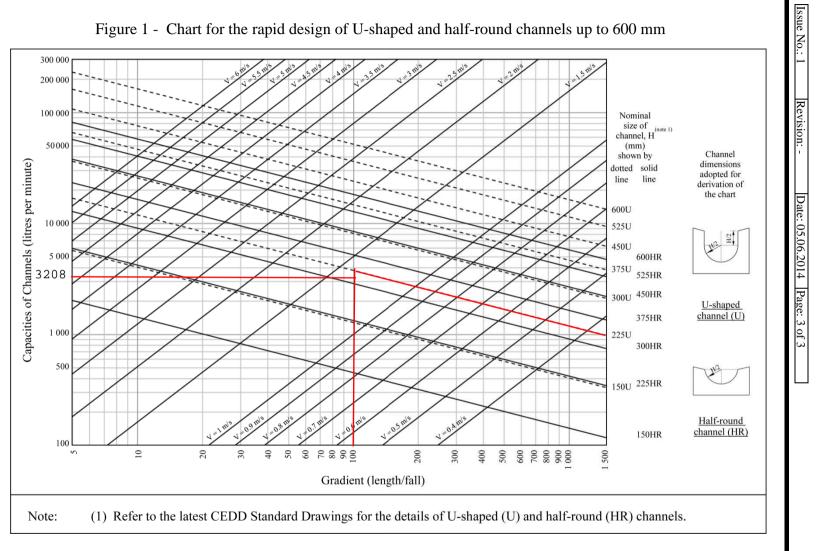

ANNEX TGN 43 A1

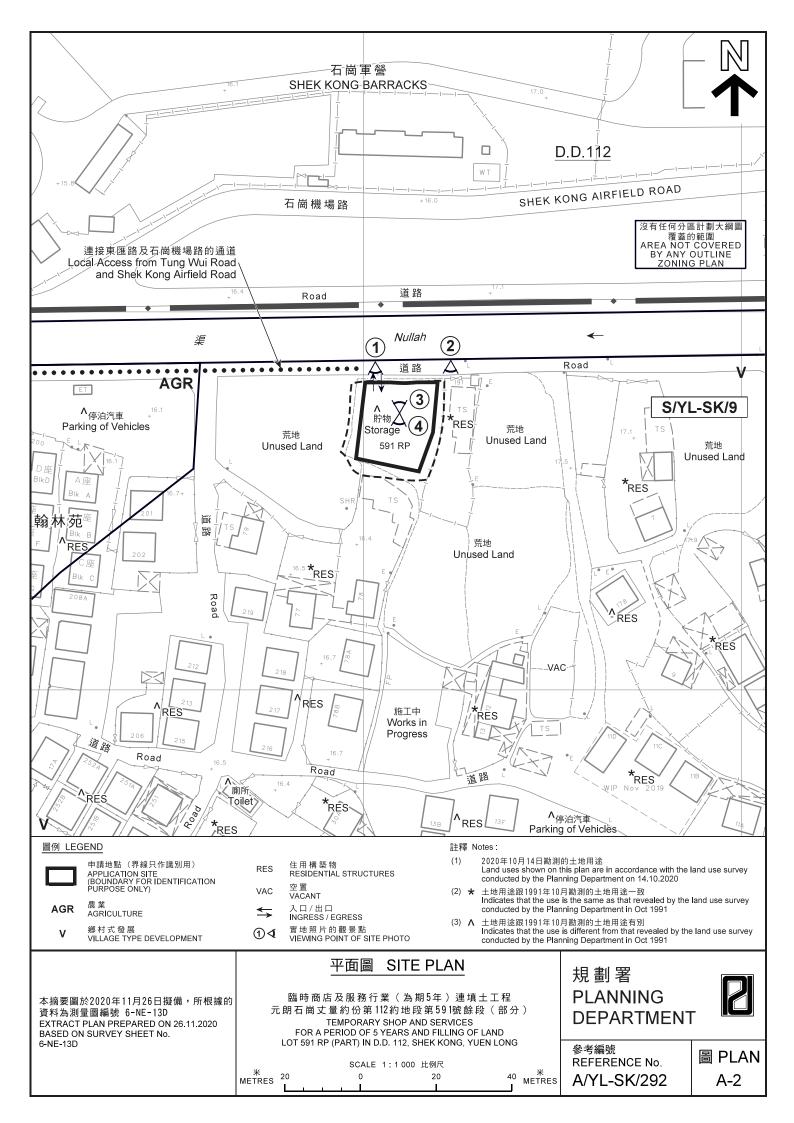









申請地點界線只作識別用 APPLICATION SITE BOUNDARY FOR IDENTIFICATION PURPOSE ONLY

本摘要圖於2020年11月19日擬備, 所根據的資料為攝於 2020年10月14日的實地照片 PLAN PREPARED ON 19.11.2020 BASED ON SITE PHOTOS TAKEN ON 14.10.2020

實地照片 SITE PHOTO

臨時商店及服務行業(為期5年)連填土工程 元朗石崗丈量約份第112約地段第591號餘段(部分) TEMPORARY SHOP AND SERVICES FOR A PERIOD OF 5 YEARS AND FILLING OF LAND LOT 591 RP (PART) IN D.D. 112, SHEK KONG, YUEN LONG

規劃署 PLANNING DEPARTMENT



參考編號 REFERENCE No. A/YL-SK/292

圖PLAN A-4

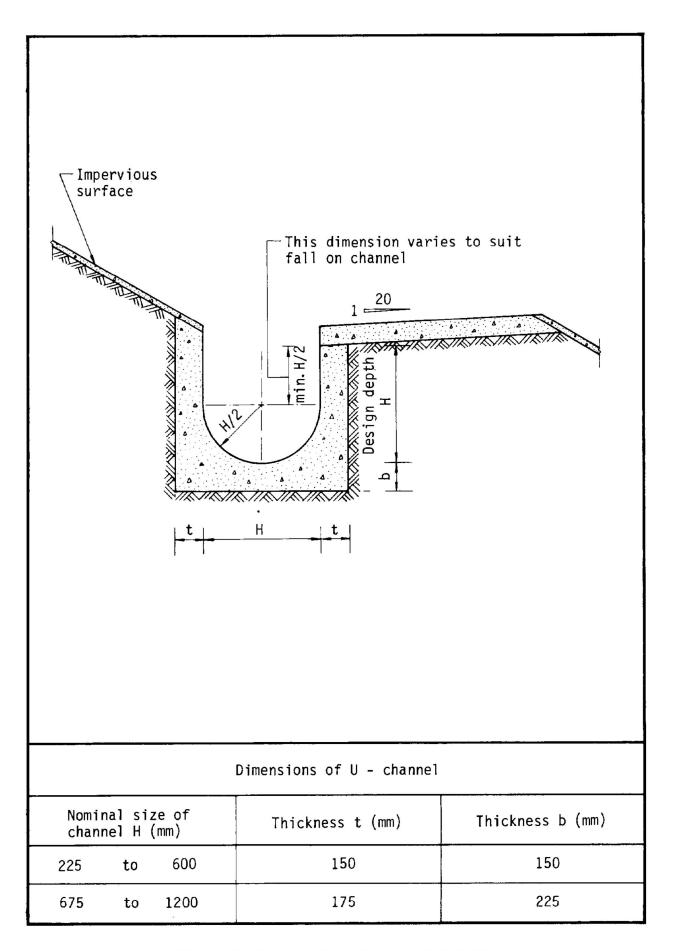


Figure 8.11 - Typical U-channel Details


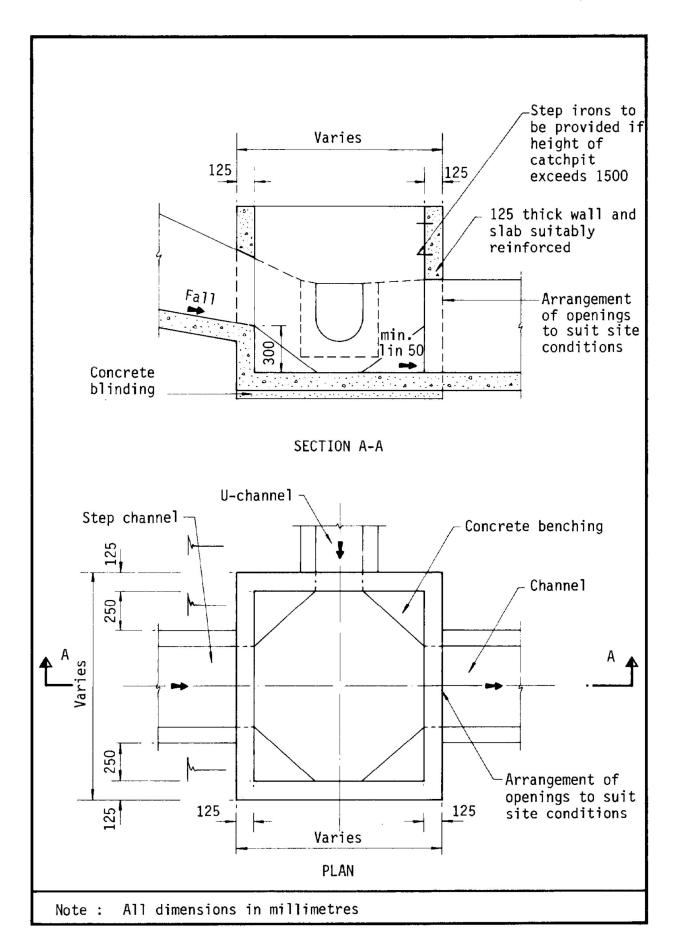


Figure 8.10 - Typical Details of Catchpits

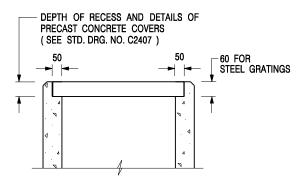

ALTERNATIVE TOP SECTION FOR PRECAST CONCRETE COVERS / GRATINGS

NOTES:

- 1. ALL DIMENSIONS ARE IN MILLIMETRES.
- 2. ALL CONCRETE SHALL BE GRADE 20 /20.
- 3. CONCRETE SURFACE FINISH SHALL BE CLASS U2 OR F2 AS APPROPRIATE.
- 4. FOR DETAILS OF JOINT, REFER TO STD. DRG. NO. C2413.
- 5. CONCRETE TO BE COLOURED AS SPECIFIED.
- UNLESS REQUESTED BY THE MAINTENANCE PARTY AND AS DIRECTED BY THE ENGINEER, CATCHPIT WITH TRAP IS NORMALLY NOT PREFERRED DUE TO PONDING PROBLEM.
- 7. UPON THE REQUEST FROM MAINTENANCE PARTY, DRAIN PIPES AT CATCHPIT BASE CAN BE USED BUT THIS IS FOR CATCHPITS LOCATED AT SLOPE TOE ONLY AND AS DIRECTED BY THE ENGINEER.
- FOR CATCHPITS CONSTRUCTED ON OR ADJACENT TO A FOOTPATH, STEEL GRATINGS (SEE DETAIL 'A' ON STD. DRG. NO. C2405) OR CONCRETE COVERS (SEE STD. DRG. NO. C2407) SHALL BE PROVIDED AS DIRECTED BY THE ENGINEER.
- 9. IF INSTRUCTED BY THE ENGINEER, HANDRAILING (SEE DETAIL 'G' ON STD. DRG. NO. C2405; EXCEPT ON THE UPSLOPE SIDE) IN LIEU OF STEEL GRATINGS OR CONCRETE COVERS CAN BE ACCEPTED AS AN ALTERNATIVE SAFETY MEASURE FOR CATCHPITS NOT ON A FOOTPATH NOR ADJACENT TO IT. TOP OF THE HANDRAILING SHALL BE 1 000 mm MIN. MEASURED FROM THE ADJACENT GROUND LEVEL.
- 10. MINIMUM INTERNAL CATCHPIT WIDTH SHALL BE 1 000 mm FOR CATCHPITS WITH A HEIGHT EXCEEDING 1 000 mm MEASURED FROM THE INVERT LEVEL TO THE ADJACENT GROUND LEVEL. AND, STEP IRONS (SEE DSD STD. DRG. NO. DS1043) AT 300 ℃ STAGGERED SHALL BE PROVIDED. THICKNESS OF CATCHPIT WALL FOR INSTALLATION OF STEP IRONS SHALL BE INCREASED TO 150 mm.
- FOR RETROFITTING AN EXISTING CATCHPIT WITH STEEL GRATING, SEE DETAIL 'F' ON STD. DRG. NO. C2405.
- SUBJECT TO THE APPROVAL OF THE ENGINEER, OTHER MATERIALS CAN ALSO BE USED AS COVERS / GRATINGS.

- FORMER DRG. NO. C2406J. Original Signed 03.2015
REF. REVISION SIGNATURE DATE


CIVIL ENGINEERING AND
DEVELOPMENT DEPARTMENT

CATCHPIT WITH TRAP (SHEET 2 OF 2)

 SCALE 1:20
 DRAWING NO.

 DATE JAN 1991
 C2406 /2

卓越工程 建設香港 We Engineer Hong Kong's Development

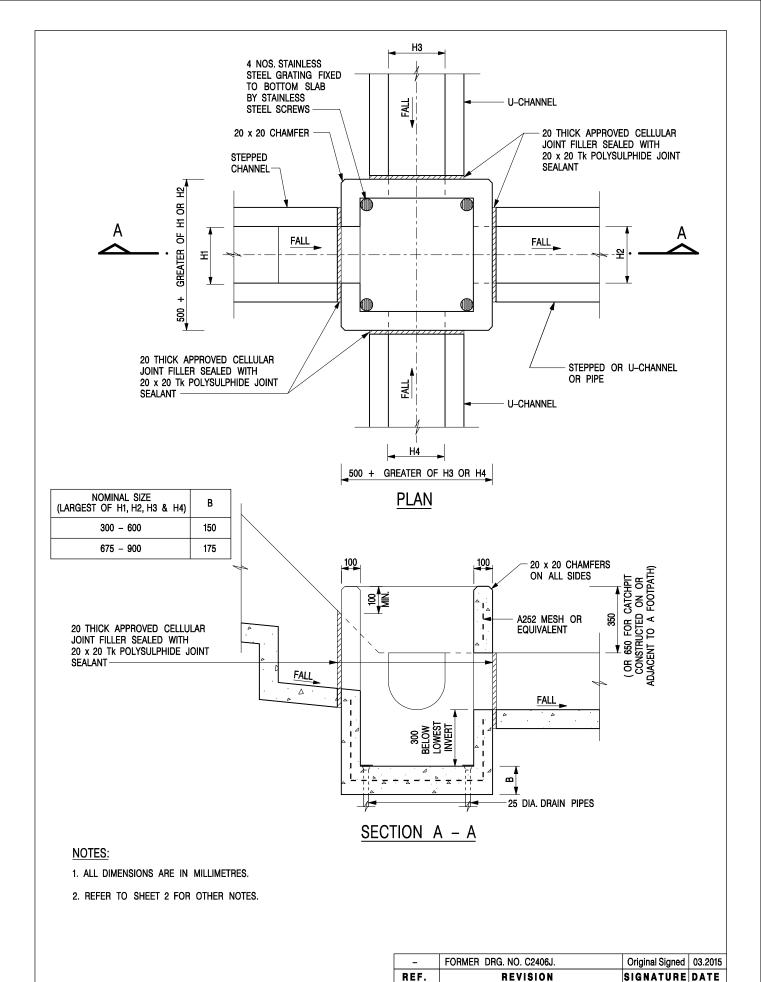

CATCHPIT WITH TRAP (SHEET 1 OF 2)

CEDD **DEVELOPMENT DEPARTMENT** SCALE 1:20 **DATE** JAN 1991

DRAWING NO. C2406 /1

CIVIL ENGINEERING AND

卓越工程 建設香港

We Engineer Hong Kong's Development

Appendix II

Planning Department

Fanling, Sheung Shui & Yuen Long East District Planning Office Unit 2202, 22/F, CDW Building, 388 Castle Peak Road, Tsuen Wan, N.T.

規劃署

粉嶺、上水及元朗東規劃處 新界荃灣青山公路 388 號 中染大廈 22 樓 2202 室



來函檔號

Your Reference:

本署檔號

Our Reference :

TPB/A/YL-SK/292

在活動碼

Tel, No. :

3168 4072

傳真機號碼

Fax No. :

3168 4074/3168 4075

R-riches Property Consultants Limited 208F, Kat Hing Wai, Kam Tin, Yuen Long, N. T.

(Attn: Matthew NG/ Grace WONG)

By Post & Fax (2323 3662)

2 January 2024

Dear Sir/ Madam,

Submission for Compliance with Approval Condition (h) – the Implementation of the Fire Service Installation Proposal

Proposed Temporary Shop and Services for a Period of 5 Years and Filling of Land in "Village Type Development" Zone, Lot 591 RP (Part) in D.D. 112, Shek Kong, Yuen Long

(Application No. A/YL-SK/292)

I refer to your submission dated 3.11.2023 for compliance with the captioned approval condition. The relevant department has been consulted on your submission. Your submission is considered:

- Acceptable. The captioned condition has been complied with.
- Acceptable. Since the captioned condition requires both the submission and implementation of the proposal, it has not been fully complied with. Please proceed to implement the accepted proposal for full compliance with the approval condition.
- Not acceptable. The captioned condition <u>has not been complied with</u>.

Should you have any queries on the departmental comments, please contact Mr. CHEUNG Wing Hei (Tel.: 2733 7737) of the Fire Services Department directly.

Yours faithfully,

(Anthony LUK)

District Planning Officer/ Fanling Sheung Shui & Yuen Long East

Planning Department

FSYLE/DPO P.002/002

- 2 -

<u>c.c.</u> D of FS

(Attn.: Mr. CHEUNG Wing Hei)

Internal CTP/TPB

AL/RS/M\$/th

DEVELOPMENT PARAMETERS OF THE APPLICATION SITE

APPLICATION SITE AREA : 431m² (ABOUT)
COVERED AREA : 234m² (ABOUT)
UNCOVERED AREA : 197m² (ABOUT)

PLOT RATIO : 0.5 (ABOUT) SITE COVERAGE : 54% (ABOUT)

NO. OF STRUCTURE : 6

DOMESTIC GFA : NOT APPLICABLE
NON-DOMESTIC GFA : 234m² (ABOUT)
BUILDING HEIGHT : 3.3m - 3.8m (ABOUT)

NO. OF STOREY :


STRUCTURE	USE	COVERED AREA	GFA	BUILDING HEIGHT
B1	SHOP & SERVICES (SOLAR PANEL)	22m² (ABOUT)	22m² (ABOUT)	3.5m (ABOUT)(1-STOREY)
B2	SHOP & SERVICES (SOLAR PANEL)	22m ² (ABOUT)	22m ² (ABOUT)	3.5m (ABOUT)(1-STOREY)
B3	SITE OFFICE AND MEETING ROOM	41m ² (ABOUT)	41m ² (ABOUT)	3.8m (ABOUT)(1-STOREY)
B4	SITE OFFICE AND MEETING ROOM	24m ² (ABOUT)	24m ² (ABOUT)	3.3m (ABOUT)(1-STOREY)
B5	RAIN SHELTER (CANOPY)*	45m ² (ABOUT)	45m ² (ABOUT)	3.5m (ABOUT)(1-STOREY)
B6	RAIN SHELTER (CANOPY)*	80m² (ABOUT)	80m ² (ABOUT)	3.5m (ABOUT)(1-STOREY)
	TOTAL	234m² (ABOUT)	234m² (ABOUT)	

STRUCTURES B1 TO B4 ARE CONTAINER CONVERTED STRUCTURE WITH SOLAR PANELS FITTED AT THE ROOF STRUCTURES B5 AND B6 ARE SHED STRUCTURES WITH SOLAR PANELS FITTER AT THE ROOF

 $^{\sharp}$ ELECTRICITY GENERATED BY THE SOLAR PANELS ON THE ROOF OF STRUCTURES B1 TO B4 ARE FOR THE USE OF THE PROPOSED DEVELOPMENT ONLY

INGRESS / EGRESS 8m (W)(ABOUT)



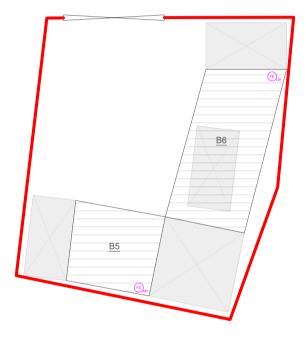

SHED STRUCTURES

LEGEND

ENCLOSED STRUCTURE SHED STRUCTURE

INGRESS / EGRESS

7.1.7.1.1.1.1.1.1.1.1.1.1.1.1.1.1.1.1.1	
APPENDIX I	02
Drawing No.	Ver.

NORTH

PROPOSED TEMPORARY SHOP AND SERVICES (SOLAR POWER SYSTEM) FOR A PERIOD OF 5 YEARS AND LAND FILLING

LOT 591 RP (PART) IN D.D. 112

	Drawing Title		
FSIs PROPOSAL			
	Scale of A4		
	1:300		
	Drawn	Date	
		18.5.2021	
	Revised	Date	

3.11.2023

FIRE SERVICE INSTALLATIONS

EXIT SIGN

EMERGENCY LIGHT

_ -

5 KG DRY POWDER TYPE FIRE EXTINGUISHER

FS NOTES:

- SUFFICIENT EMERGENCY LIGHTING SHALL BE PROVIDED THROUGHOUT THE ENTIRE BUILDING IN ACCORDANCE WITH BS5266-1:2016 AND BS EN1838:2013 AND FSD CIRCULAR LETTER 4/2021
- SUFFICIENT DIRECTIONAL AND EXIT SIGN SHALL BE PROVIDED IN ACCORDANCE WITH BS5266-1:2016 AND FSD CIRCULAR LETTER 5/2008.
- PORTABLE HAND-OPERATED APPROVED APPLIANCE SHALL BE PROVIDED AS REQUIRED BY OCCUPANCY.
- 4. ACCESS IS PROVIDED FOR EMERGENCY VEHICLE TO REACH 30m OF ALL PART OF STRUCTURES.

FIRE SERVICE (INSTALLATIONS AND EQUIPMENT) REGULATIONS A 9000082 消防(裝置及設備)規例 FSD Ref : (Regulation 9(1)) 消防處檔號 (第九條(1)款) CERTIFICATE OF FIRE SERVICE INSTALLATION AND EQUIPMENT 消防裝置及設備證書 Name of Client: 顧客姓名 Name of Building: 樓字名稱 Lot 591 RP(Part), in D.D.112 Street No./Town Lot: Street/Road/Estate Name: 門牌號數/市地段 街道/屋苑名稱 HK Block : District: Area : Filling 新界 分區 地區 香港 九龍 Type of Building 樓宇類型: Industrial工業 Licensed premises持牌處所 Institutional社團 □ Commercial商業 □ Domestic住宅 □ Composite綜合 In accordance with Regulation 8(b) of Fire-Service (Installations and Equipment) Regulations, the owner of any fire service installation of **Part 1 Annual Inspection ONLY** equipment which is installed in any premises shall have such fire service installation or equipment inspected by a registered contractor at least once m every 12 months. 根據消防(裝置及設備)規例第八條(b)款,擁有裝置在任何處所內的任何消防裝置或設備的人, 第一部 只適用於年檢事項 once m every 12 months. 根據消防(裝置及設備)規例第八條(b)款,須每12個月由一名註冊承辦商檢查該等消防裝置或設備至少一次。 Completion Date Next Due Date 下次到期日(DD/MM/YY) Code編碼 (1-35) Type of FSI 裝置類型 Location(s) 位置 Comment on Condition 狀況評述 完成日期(DD/MM/YY) NIL Alurm System (MEA) 火藝學提系是 Control Centre 游扬控制中心 Part 2 第二部 Installation / Modification / Repair / Inspection work 裝置/改裝/修理/檢查工作 Code編碼 (1-35) Completion Date 完成日期(DD/MM/YY Type of FSI 裝置類型 Location(s) 位置 Nature of Work Carried out 完成之工作內容 Comment on Condition 狀況評述 G/F Conforms with FSD 24 6 x 5Kg Dry Powder F.E Supply & Install 02-11-2023 requirements Fixed Automatically Operated Approved Appliance 属可的自動操作固定蓝星 Fixed Foun System 图 定電床事業 Gas Deniction System 真應值明系統 Part 3 第三部 Defects 損壞事項 Code編碼 (1-35) Type of FSI 裝置類型 Location(s) 位置 Outstanding Defects 未修缺點 Comment on Defects 缺點評述 NIL I/We hereby certify that the above installations/equipment have been tested and found to be in efficient working order in accordance with the Codes of Practice for Minimum Fire Service Installations and Authorized For FSD Signature : Equipment and Inspection, Testing and Maintenance of Installations and Equipment published from time 受權人簽署 Ng Wai to time by the Director of Fire Services. Defects are listed in Part 3 Name 姓名 本人藉此證明以上之消防裝置及設備經試驗,證明性能良好,符 RC3/690 Inspected FSD/RC No.: 消防處註冊號碼 合消防處處長不時公佈的最低限度之消防裝置及設備守則與裝置

或處所當眼處以供消防處人員查核

及設備之檢查測試及保養守則的規格,損壞事項列於第三部。

This certificate should be displayed at prominent location of the building or premises

for FSD's inspection if any annual maintenance work is involved.

Company Name: 公司名稱 Telephone:

聯絡電話 Date:

日期

Key-in

Verified

East Power Engineering Ltd 東力工程有限公司

2789 3690 03-11-2023

F.S. 251 (Rev. 1/2016)